
246 CANTERBURY RD, REVESBY NSW 2212

Drawing No.	Sheet Name	Current Revision	Sheet Issue Date
SW-01	STORMWATER DRAINAGE PLAN	A	02/12/2025
SW-02	STORMWATER DRAINAGE DETAILS	Α	02/12/2025
SW-03	STORMWATER DRAINAGE DETAILS	A	02/12/2025
SW-04	STODMWATED DRAINIAGE DETAILS	Λ	02/12/2025

DRAWING INDEX

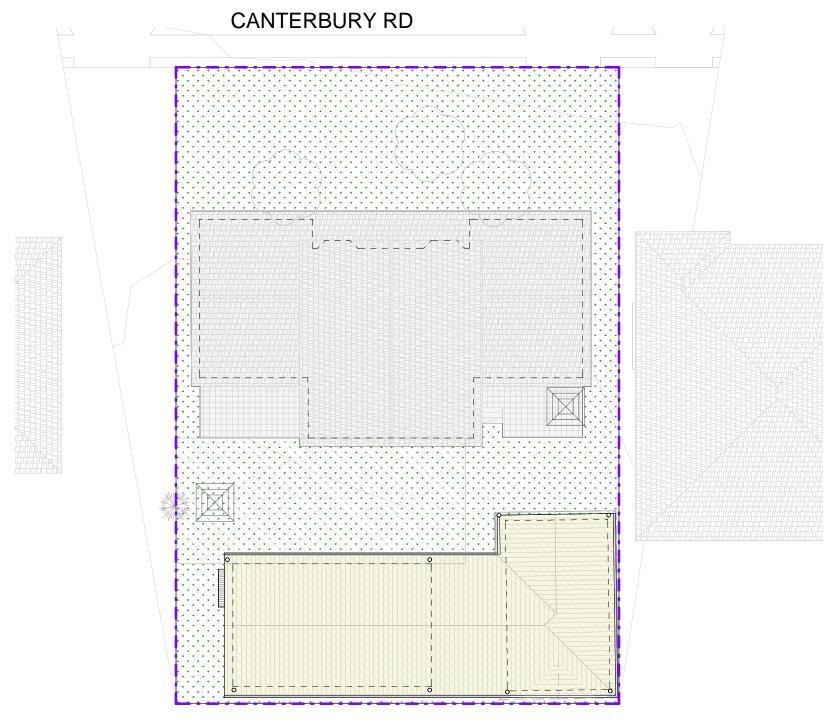

LOCATION PLAN

Rev	Description	Ву	Date
Α	ISSUED FOR DEVELOPMENT APPLICATION	A.L.	12.02.2025
]	
		1	

Legend & Notes

MEASUREMENTS TO BE CONFIRMED ON SITE, NO MEASUREMENTS TO BE SCALED OFF DRAWINGS



Client


Anwar El-Ache & Said El-Ache

Project Address

246 CANTERBURY RD, REVESBY NSW 2212

Designed	S.D.	Scale	1:200
Drawn	A.L.	Date	12.02.2025
Checked	S.D.	Rev	В
Drawing N	umber SW-00	Job Number	S-25008

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STORMWATER DRAINAGE PLAN

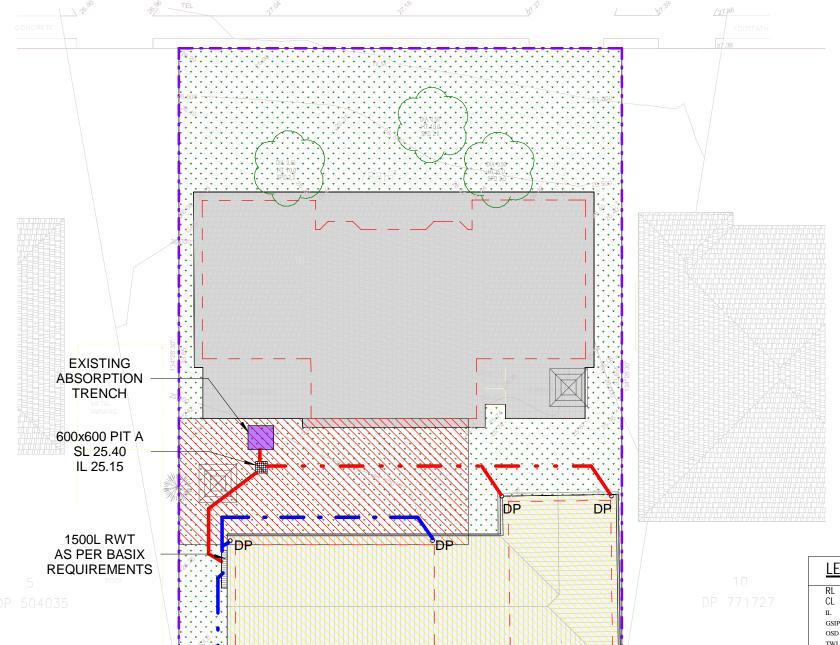RECYCLED WATER IN USE : 451.6 m² : 260.9 m² DO NOT DRINK



Impervious Area Calculation

Site area Impervious Area Increase in Impervious Area No OSD Required < 30 m²

Legend & Notes

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Project Address 246 CANTERBURY RD, REVESBY NSW 2212

Drawing Title STORMWATER DRAINAGE PLAN 1:200 Designed S.D. Scale 12.02.2025 Date Checked S.D. S-25008 Drawing Number SW-01

LEGEND

REDUCED LEVEL COVER LEVEL INVERT LEVEL GRATED SURFACE INLET PIT GSIP

ON-SITE DETENTION TOP WATER LEVEL BOTTOM WATER LEVEL TW IO TOP OF WALL

INSPECTION OPENING RAINWATER TANK RWT SEDIMENT PIT AVERAGE RECURRENCE INTERVAL

AUSTRALIAN HEIGHT DATUM PERMISSIBLE SITE DISCHARGE HIGH EARLY DISCHARGE AHD

RECTANGULAR HOLLOW SECTION RHS STAINLESS STEEL FIBER REINFORCED CONCRETE

REINFORCED CONCRETE PIPE RCP RUBBER RING JOINT RRJ UNDERSIDE OF SLAB OVERFLOW

U/S O/F NWO RWH DROPPER

PROPOSED DIDE - PROPOSED DOWNPIPE (100x50/ 90 DIA. U.N.O.) - PROPOSED DOWNPIPE SPREADER (100x50/ 90 DIA. U.N.O.)

- PROPOSED PIPE - PROPOSED PIPE

NOTE:

THE BUILDER OR PLUMBER ARE TO SURVEY AND INVESTIGATE THAT THE EXISTING SYSTEM IS IN GOOD WORKING ORDER PRIOR TO CONNECTING. IF THE SYSTEM IS UNSATISFACTORY, THEN THIS OFFICE IS TO BE NOTIFIED IMMEDIATELY ON 02 8319 9449

TREE NOTES

CONDITION 21) d) - THE STORMWATER LINE THAT RUNS PARALLEL ALONG THE EASTERN BOUNDARY OF UNIT A SHALL BE NO CLOSER THAN 3.2m RADIUS FROM THE TRUNK OF THE NEIGHBOURS EUCALYPTUS FIBROSA (BROAD LEAF IRONBARK) TREE, LOCATED AT NUMBER 106 CANN ST. BASS HILL. NO ROOTS OVER 25mm are to be cut or damaged. Works within the tree protection zone shall comply WITH SECTION 4.5.5 OF THE AUSTRALIAN STANDARD AS4970-2009 PROTECTION OF TREES ON DEVELOPMENT SITES.

STORMWATER NOTES:

STORMWATER DRAINAGE ELEMENTS OUTSIDE THE PROPERTY BOUNDARY SHALL BE CONSTRUCTED UNDER SATISFACTION OF COUNCIL.

FINISHED CROSSING AND DRIVEWAY LEVELS ARE BASED ON SURFACE LEVELS OF THE EXISTING LAYBACK AND STREET

BEFORE COMMENCING CONSTRUCTION OF THE CROSSING AND DRIVEWAY. COUNCIL'S DESIGNED STREET BOUNDARY LEVELS MUST BE OBTAINED AND USED FOR CONSTRUCTION.


THE DESIGN FINISHED SURFACE LEVELS OF THE STREET BOUNDARY MUST BE OBTAINED BY APPLICATION TO COUNCIL AND PAYMENT OF THE APPROPRIATE FEE TO


STORMWATER DESIGN IS IN ACCORDANCE WITH COUNCIL'S DCP AND WITH AS3500

		PIPE SCHEDULE	
TAG	PIPE SIZE	COMMENT	LINETYPE
P1	& IUUIIIII UE VC	MIN 1% OR CHARGED TO RAIN WATER TANK	
P2	Ø100mm UPVC SEWER GRADE	MIN 1% FALL	
P3	125mm x 50mm RHS	MIN 1% FALL TO BE KERB	

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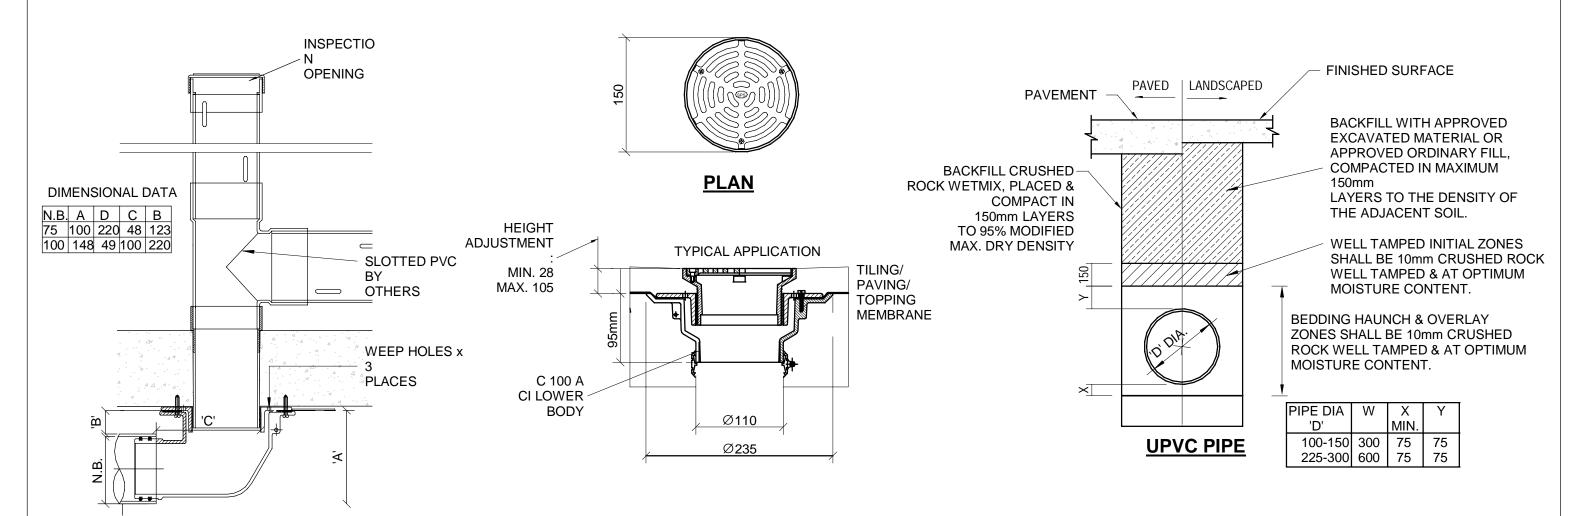


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eaend & Notes MEASUREMENTS TO BE CONFIRMED ON SITE, NO MEASUREMENTS TO BE SCALED OFF DRAWINGS
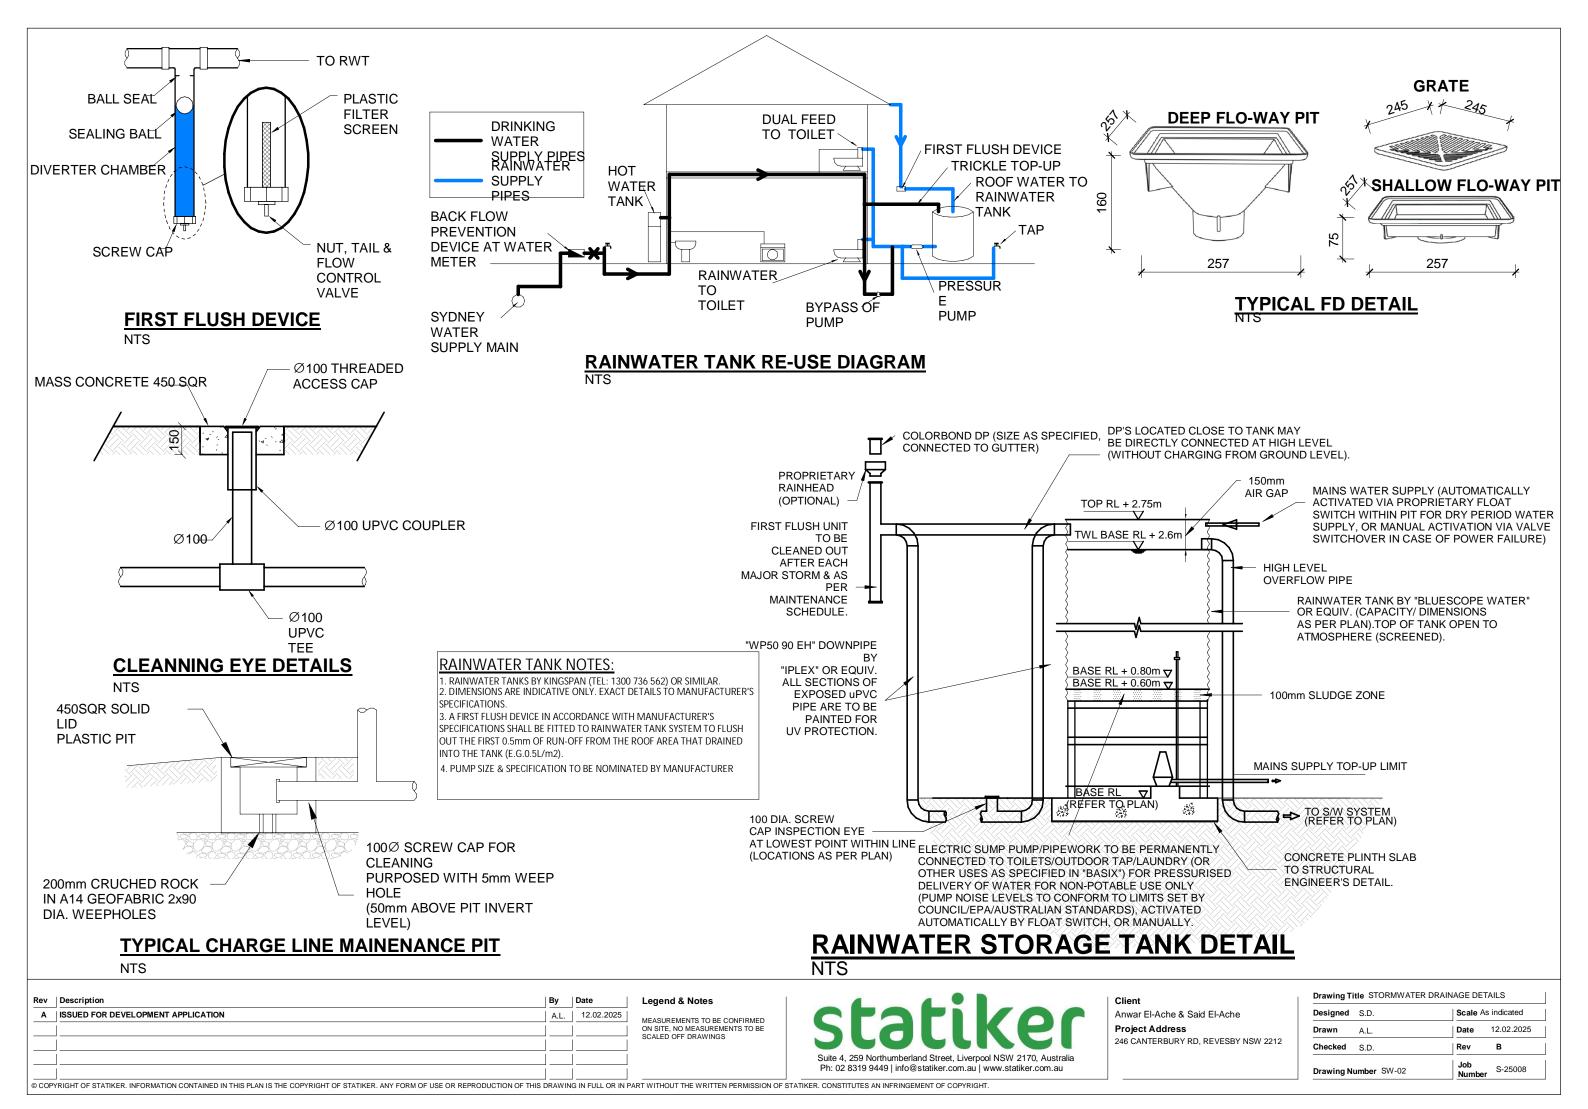
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Anwar El-Ache & Said El-Ache Project Address 246 CANTERBURY RD, REVESBY NSW 2212 Drawing Title STORMWATER DRAINAGE DETAILS Scale As indicated Designed S.D. Date 12.02.2025 Checked S.D. S-25008 Drawing Number SW-03

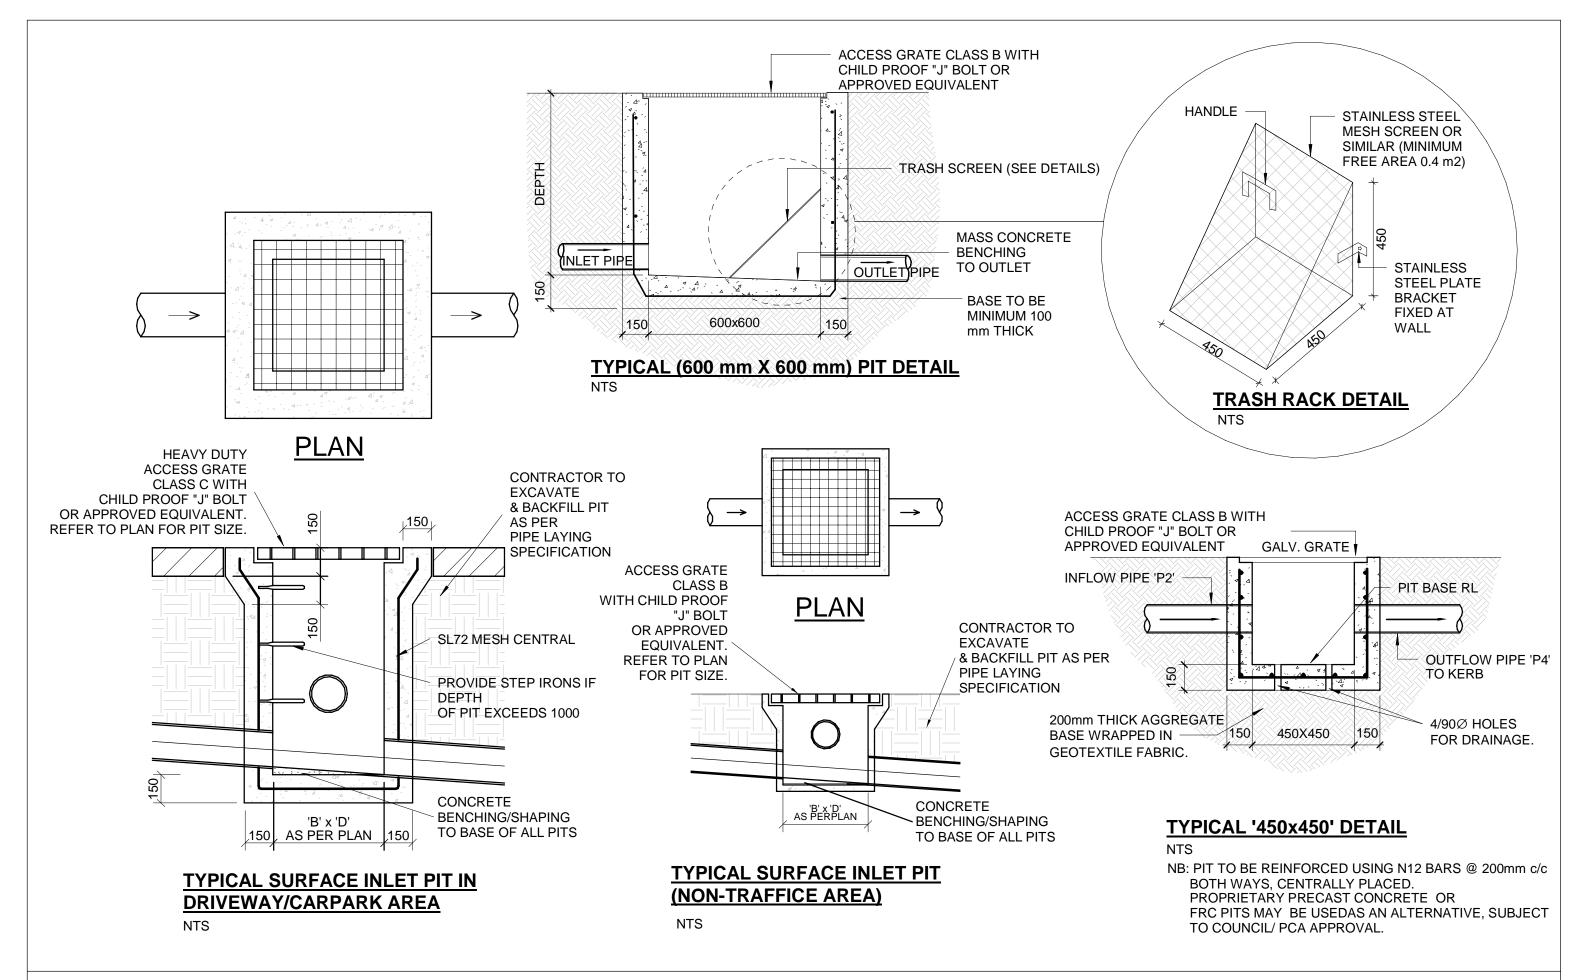

SPS TRUFLO 100SQ OR EQUIVALENT PLANTER BOX DRAIN

NTS

SPS TRUFLO Ø150 OR
EQUIVALENT FLOOR DRAINS (FW)
INLET IN SUSPENDED SLAB

NTS

SPECIFICATION CODE: R150 G/C (BRONZE GRATE, CI LOWER BODY)
SPECIFICATION CODE: R150N/C (NICKEL - BRONZE GRATE, CI LOWER BODY)

TYPICAL PIPE LAYING DETAIL

NTS

Rev	Description	Ву	Date
Α	ISSUED FOR DEVELOPMENT APPLICATION	A.L.	12.02.2025
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		l	1

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Designed	S.D.	Scale	1:100
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